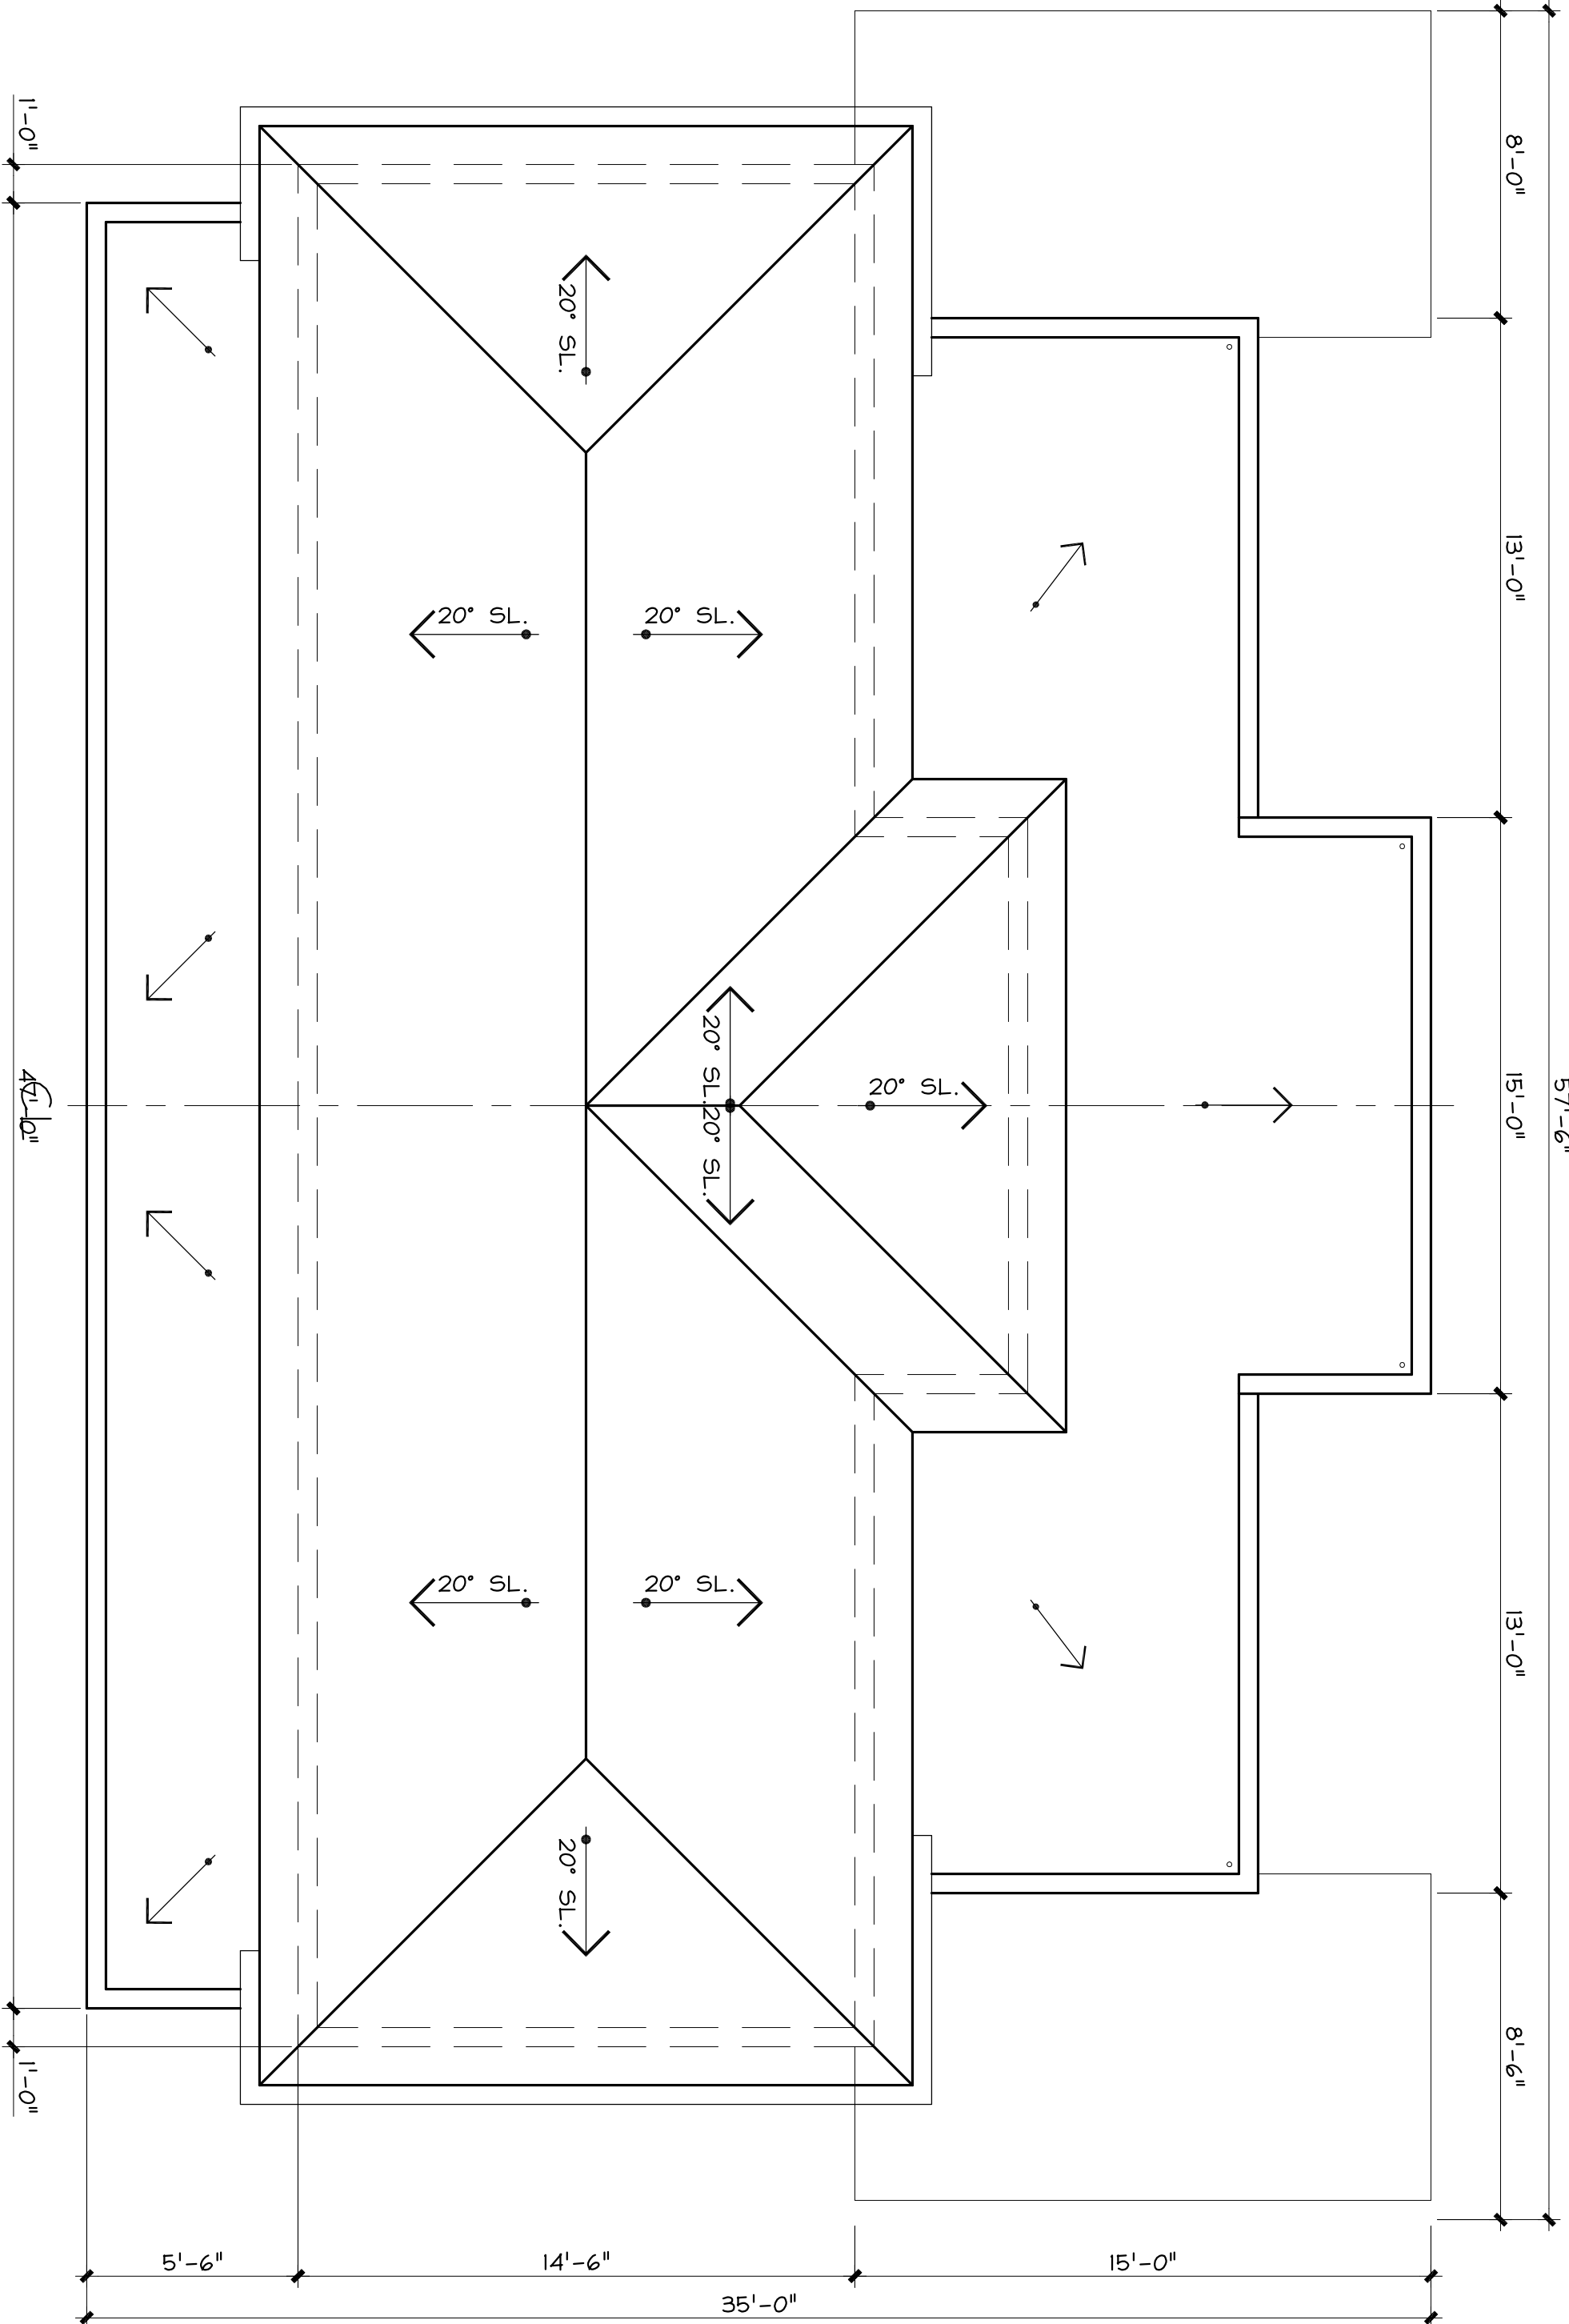
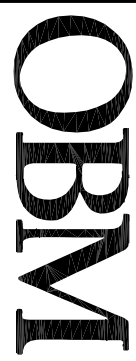


1		2		3		4		5		6					
<div></div>								<div><div><div>A) STANDING SEAM METAL ROOFING 22ga ZINC w/ PFG ACCESSORIES</div><div>B) FLASHING TO MATCH ROOFING</div><div>C) R.C. ROOF SLAB: R.C. ROOF SLAB AS PER STRUCTURAL w/ "ZYTEX" OR SIM WATERPROOFING</div><div>D) 5 1/2" THK. R.C. ROOF SLAB AS PER STRUCTURAL w/ "ZYTEX" OR SIM WATERPROOFING</div><div>E) 2"x8" HONDURAS PINE RIDGE</div><div>F) 2"x12" HONDURAS PINE RIDGE</div><div>G) 2"x8" HONDURAS PINE RAFTERS</div><div>H) 2"x8" HONDURAS PINE FASCIA w/ ROUTED DRIP</div><div>J) EXPOSED RAFTER TAILS PAINTED</div><div>K) 2"x4" WPP PURLINS @ 24" O/C</div><div>L) "REFLECTRIX" OR SIM RADIANT BARRIER</div><div>M) 3/4" THK. CDX PLYWOOD SHEATHING</div><div>N) TYP. PVC. OGEE GUTTER AND DOWN SPOUT</div><div>P) 8"x16" R.C. BEAM AS PER STRUCTURAL</div><div>Q) 6"x16" R.C. BEAM AS PER STRUCTURAL</div><div>R) R.C. UPSTAND AS PER STRUCTURAL</div><div>S) 6"x8" R.C. CAPPING BEAM AS PER STRUCTURAL</div><div>T) 6"x6" R.C. CAPPING BEAM AS PER STRUCTURAL</div><div>U) 6" THK. REINF. BLOCK WALLS AS PER STRUCTURAL</div><div>V) 8" THK. REINF. BLOCK WALLS AS PER STRUCTURAL</div><div>W) "HARDI-PLANK" SIDING (6) & TRIM.</div><div>X) 2"x2" FURRING STRIPS AT 24" O/C</div><div>Y) STAINLESS STEEL HURRICANE STRAPS</div><div>Z) AS PER SCHEDULE</div><div>AA) R.C. FLOOR SLAB AS PER STRUCTURAL</div><div>AB) PLASTER ON MASONRY - PAINTED</div><div>AC) RAISED CONCRETE BAND</div><div>AD) 3/4" DEEP X 1" WIDE REGLET</div><div>AE) UPVC RAILING SYSTEM FIXED AS PER MANUFACTURER'S SPECIFICATIONS</div><div>AF) 1"x4" W.P.P. CLOSER STRIP</div><div>AG) R.C. UPSTAND AS PER STRUCTURAL</div><div>AH) DRESSED TIMBER SURROUND</div><div>AI) WOODEN DOOR FRAME</div><div>AK) 5/8" GYPSUM BOARD ON 4" GAL. STEEL STUDS.</div><div>AL) 5/8" GYPSUM BOARD ON 2"x2" CEILING FRAME AS REQUIRED</div><div>AM) KITCHEN CURBOARD UNIT TO BE SUPPLIED BY OTHER</div><div>AN) 2"x8" H.M. BEAM BOLTED TO H.M. COLUMN</div><div>AP) 2"x6" H.M. FIXED TO BEAM AT 12" O.C. WITH SIMPSON LUS26SS HANGERS OR SIM APPROVED.</div><div>AQ) 4"x4" H.M. COLUMN FIXED TO FOOTING WITH SIMPSON STAINLESS STEEL ELEVATED POST</div></div></div>							
B-1 ROOF PLAN								SCALE: 1/4"=1'-0"							
B-5 ANNOTATION TAGS								N.T.S.							
B-6 -								B-6 -							
C-6 -								C-6 -							
D-6 -								D-6 -							
A-1 -								SCALE:-							
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A-3 -								SCALE:-							
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A-5 -								SCALE:-							
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4. The Architect is not responsible for dimensions of the site plan or registered boundary survey carried out by a Licensed Land Surveyor.
5. The drawing is to be read in conjunction with the Mechanical, Electrical and / or Plumbing Specifications that is applicable to the project.

PROJECT:

CABLE BAY
DEVELOPMENT
ST. KITTS

DRAWING:

HILLSIDE
SUITES:
ROOF
PLAN

DRAWN BY: M.G.	PROJECT #: 09020
CHECKED BY: M.S.	SCALE: 1/4"=1'-0"
DRAWING #:	
IHS-105	